

#### Functional Formation Architecture, pllc

June 21, 2016

#### PROJECT NARRATIVE

Bella Via Village Shops 4425 South Mountain Road, Mesa, Az PS16-023, PLN2016-00191

The project site, located at the Southeast corner of Mountain Road and Warner Road, is currently vacant and consists of 5.27 acres. The property is zoned C-2, and is surrounded by existing single family residential neighborhoods, with the exception of a private school (American Leadership Academy) located south of the project site.

This application proposes a new property division, leaving the eastern portion, approximately 51,009 S.F. (1.17 acres), as vacant land for future commercial development. At the western portion, approximately 120,132 S.F. (2.76 acres), a new neighborhood services center is proposed.

A new site entrance driveway is proposed from Mountain Road at the south end of the parcel. A second entrance driveway is proposed from Warner Road centered on the proposed new property division. This driveway will be shared by both properties.

The new building is located approximately 141 feet from the Mountain Road Right-of-Way and approximately 79 feet from the Warner Road Right-of-Way. Parking is located along both frontages and at the rear (east side) of the new building. Fire truck access is provided around all four sides of the building and refuse containers are proposed at the rear.

The proposed new building will consist of 18,037 S.F. and is designed to accommodate up to 14 tenant spaces. The future tenants are not known but will comprise businesses that are allowed by the C-2 zoning district. Types of tenants we anticipate to lease would include a small grocer or health food market, beauty salon, medical or dental office, insurance office, restaurant, pool supply, etc.

The building architecture is primarily contemporary in style and incorporates lightly colored E.F.I.S., standing seam metal roofing, stone veneer, steel beam/trellis, and painted masonry. The front building facade incorporates a rhythmic pattern of contemporary steel trellis elements separated by a portico facing Mountain Road and visually anchored metal roof canopies at each corner. The portico and corner anchors incorporate tenant sign placement below the metal roof, while the steel trellis areas

provide sign placement on the building wall within recessed areas subtly highlighted by a steel plate at the top.

The amount of vehicular parking required is 66 spaces minimum based on 1 space per 275 S.F. of building area. The maximum number of vehicular parking spaces allowed is 83, and this is the number of spaces being provided. Four of the 83 parking spaces will be accessible parking spaces.

Storm water retention is proposed within the perimeter landscape areas with bleed off to the storm drain located in Mountain Road. A new water line is proposed to connect with the existing water line in Mountain Road, and to extend east, then north, around the new building with another connection to the existing water line in Warner Road. The new building sewer is proposed to connect with the city sewer main located in Mountain Road.

The site has 31% of its area designated to receive landscape material. The landscape plan proposes Date Palm trees mixed with Chitalpa trees behind the street corner monument wall. Fruitless Olive and Live Oak trees are placed along the street frontages. A mix of Dalbergia Sissoo and Live Oak trees are used at the perimeter landscape areas adjacent to the south and east boundaries. At the parking area, a mix of Fan West Ash and fruitless Olive are utilized, and the building foundation planting incorporates Texas Mountain Laurel trees.


If you have any comments or questions, please feel free to contact me at:


480-726-0595

Lpartch@FunForm.net

Lesley L. Partch


Functional Formation Architecture, pllc (Architect)

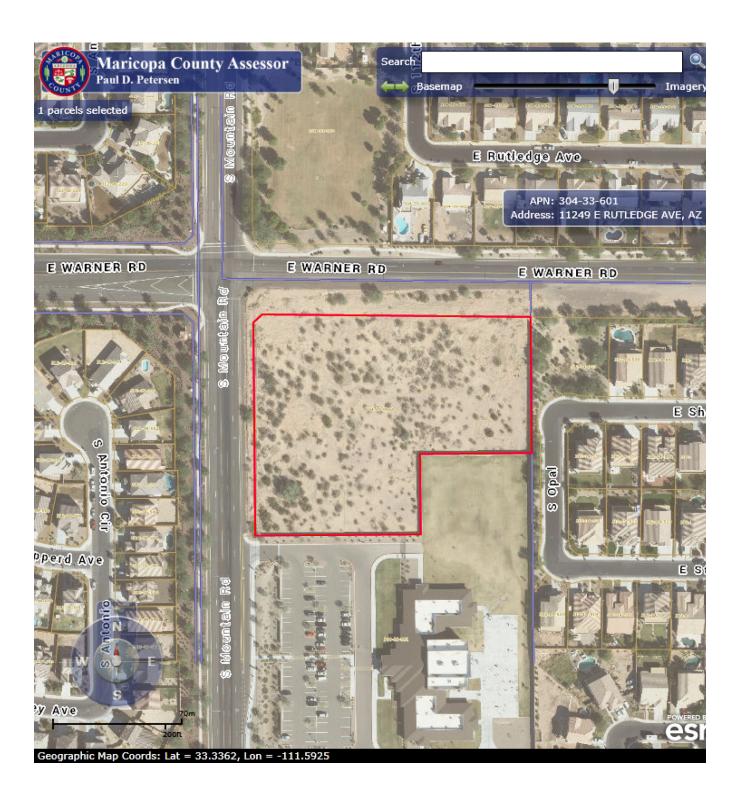

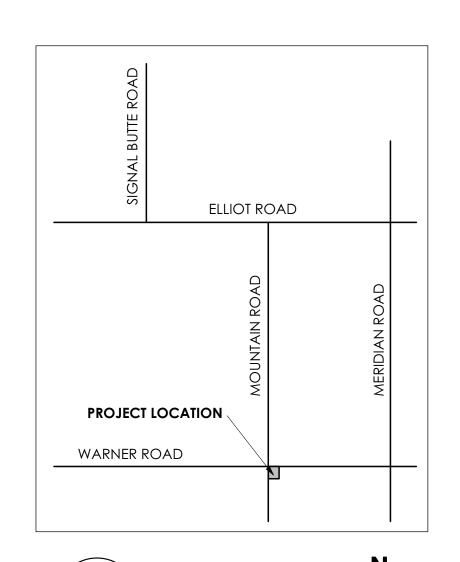

**VICINITY MAP** 

SP1

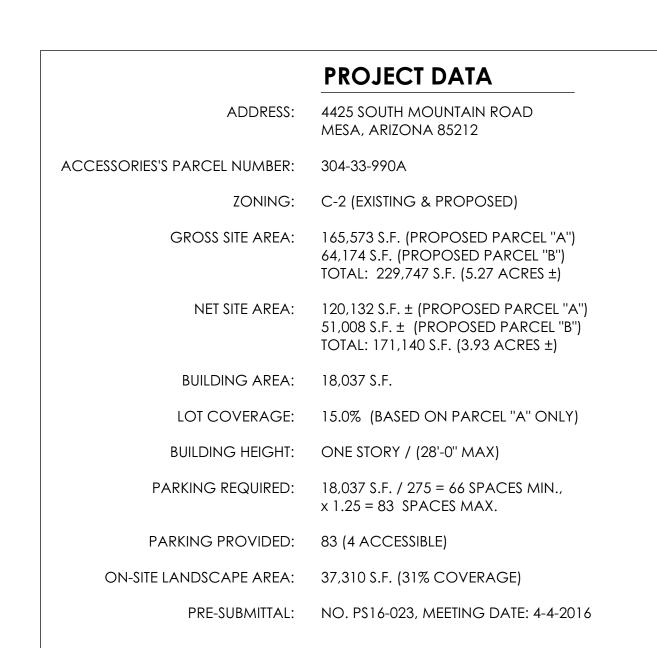

## LEGAL DESCRIPTION:

BLD'G. TYPE OF CONSTRUCTION: V-B (A.F.E.S.)

ANTICIPATED OCCUPANCIES: M, B, A-2

THE WESTERLY 555.00 FEET OF THE NORTHERLY 941.84 FEET OF THE NORTHEAST QUARTER OF SECTION 24, TOWNSHIP 1 SOUTH, RANGE 7 EAST OF THE GILA AND SALT RIVER BASE AND MERIDIAN, MARICOPA COUNTY, ARIZONA.

A PORTION OF THE WESTERLY 555.00 FEET OF THE NORTHERLY 941.84 FEET OF THE NORTHEAST QUARTER OF SECTION 24, TOWNSHIP 1 SOUTH, RANGE 7 EAST OF THE GILA AND SALT RIVER BASE AND MERIDIAN, MARICOPA COUNTY, ARIZONA DESCRIBED AS FOLLOWS:

COMMENCING AT THE BRASS CAP MONUMENT IN HAND HOLE MARKING THE NORTH QUARTER CORNER OF SAID SECTION;


THENCE S00°42'17"E., 473.00 FEET ALONG THE NORTH/SOUTH CENTER OF SECTION LINE TO THE POINT OF BEGINNING;

THENCE N8917'43"E., 352.50 FEET;

THENCE NO0'42'17"W., 466.42 FEET;


THENCE N89'38'08"W., 352.56 FEET TO THE NORTH/SOUTH CENTER OF SECTION LINE;

THENCE S00°42'17"E, 469.00 FEET ALONG SAID LINE TO THE POINT OF BEGINNING.

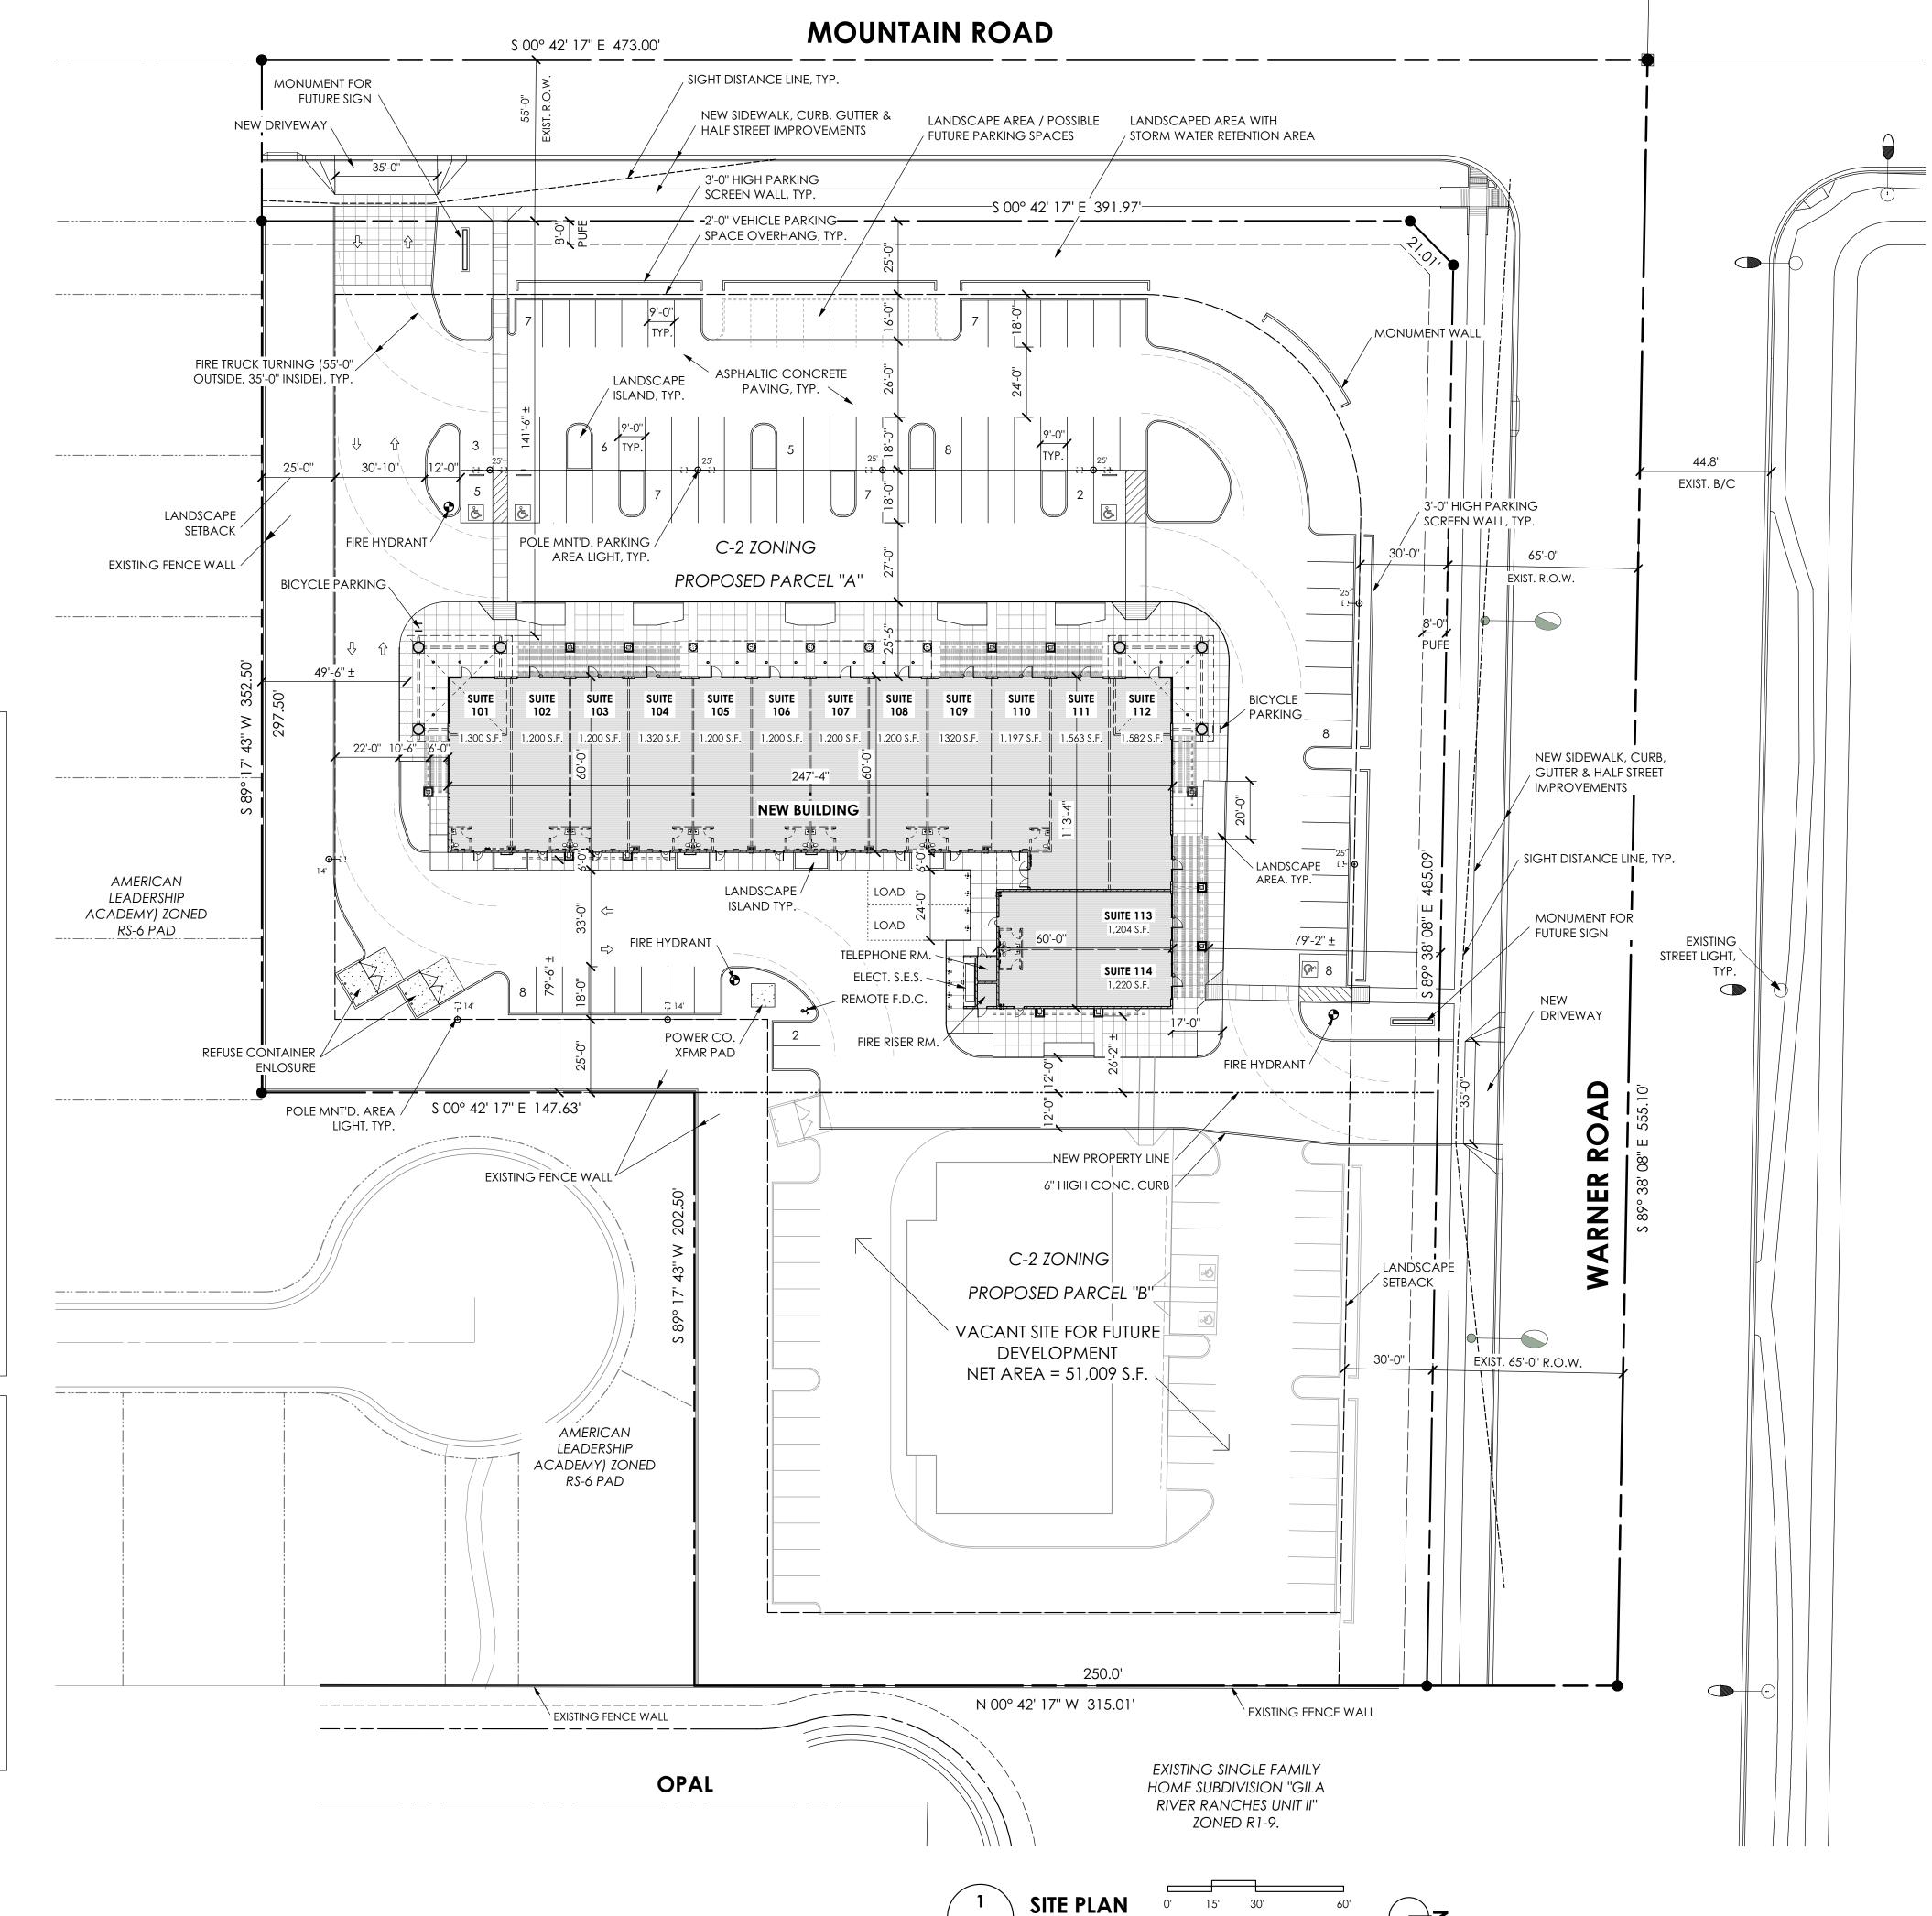

Scale: 1" = 30'-0"

NOTE: SITE PLAN HAS BEEN ROTATED 00° 42' 17" CLOCKWISE

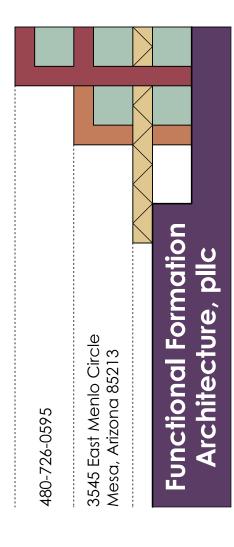



**PRELIMINARY NOT FOR** CONSTRUCTION OR RECORDING

06/17/16 DRAWING DATE

## **BELLA VIA VILLAGE** SHOPS


ΑT


4425 SOUTH MOUNTAIN ROAD MESA, AZ


CRAIG / STEVEN **DEVELOPMENT** CORPORATION

1535 PLAN SHEET NO.

**PROJECT** 

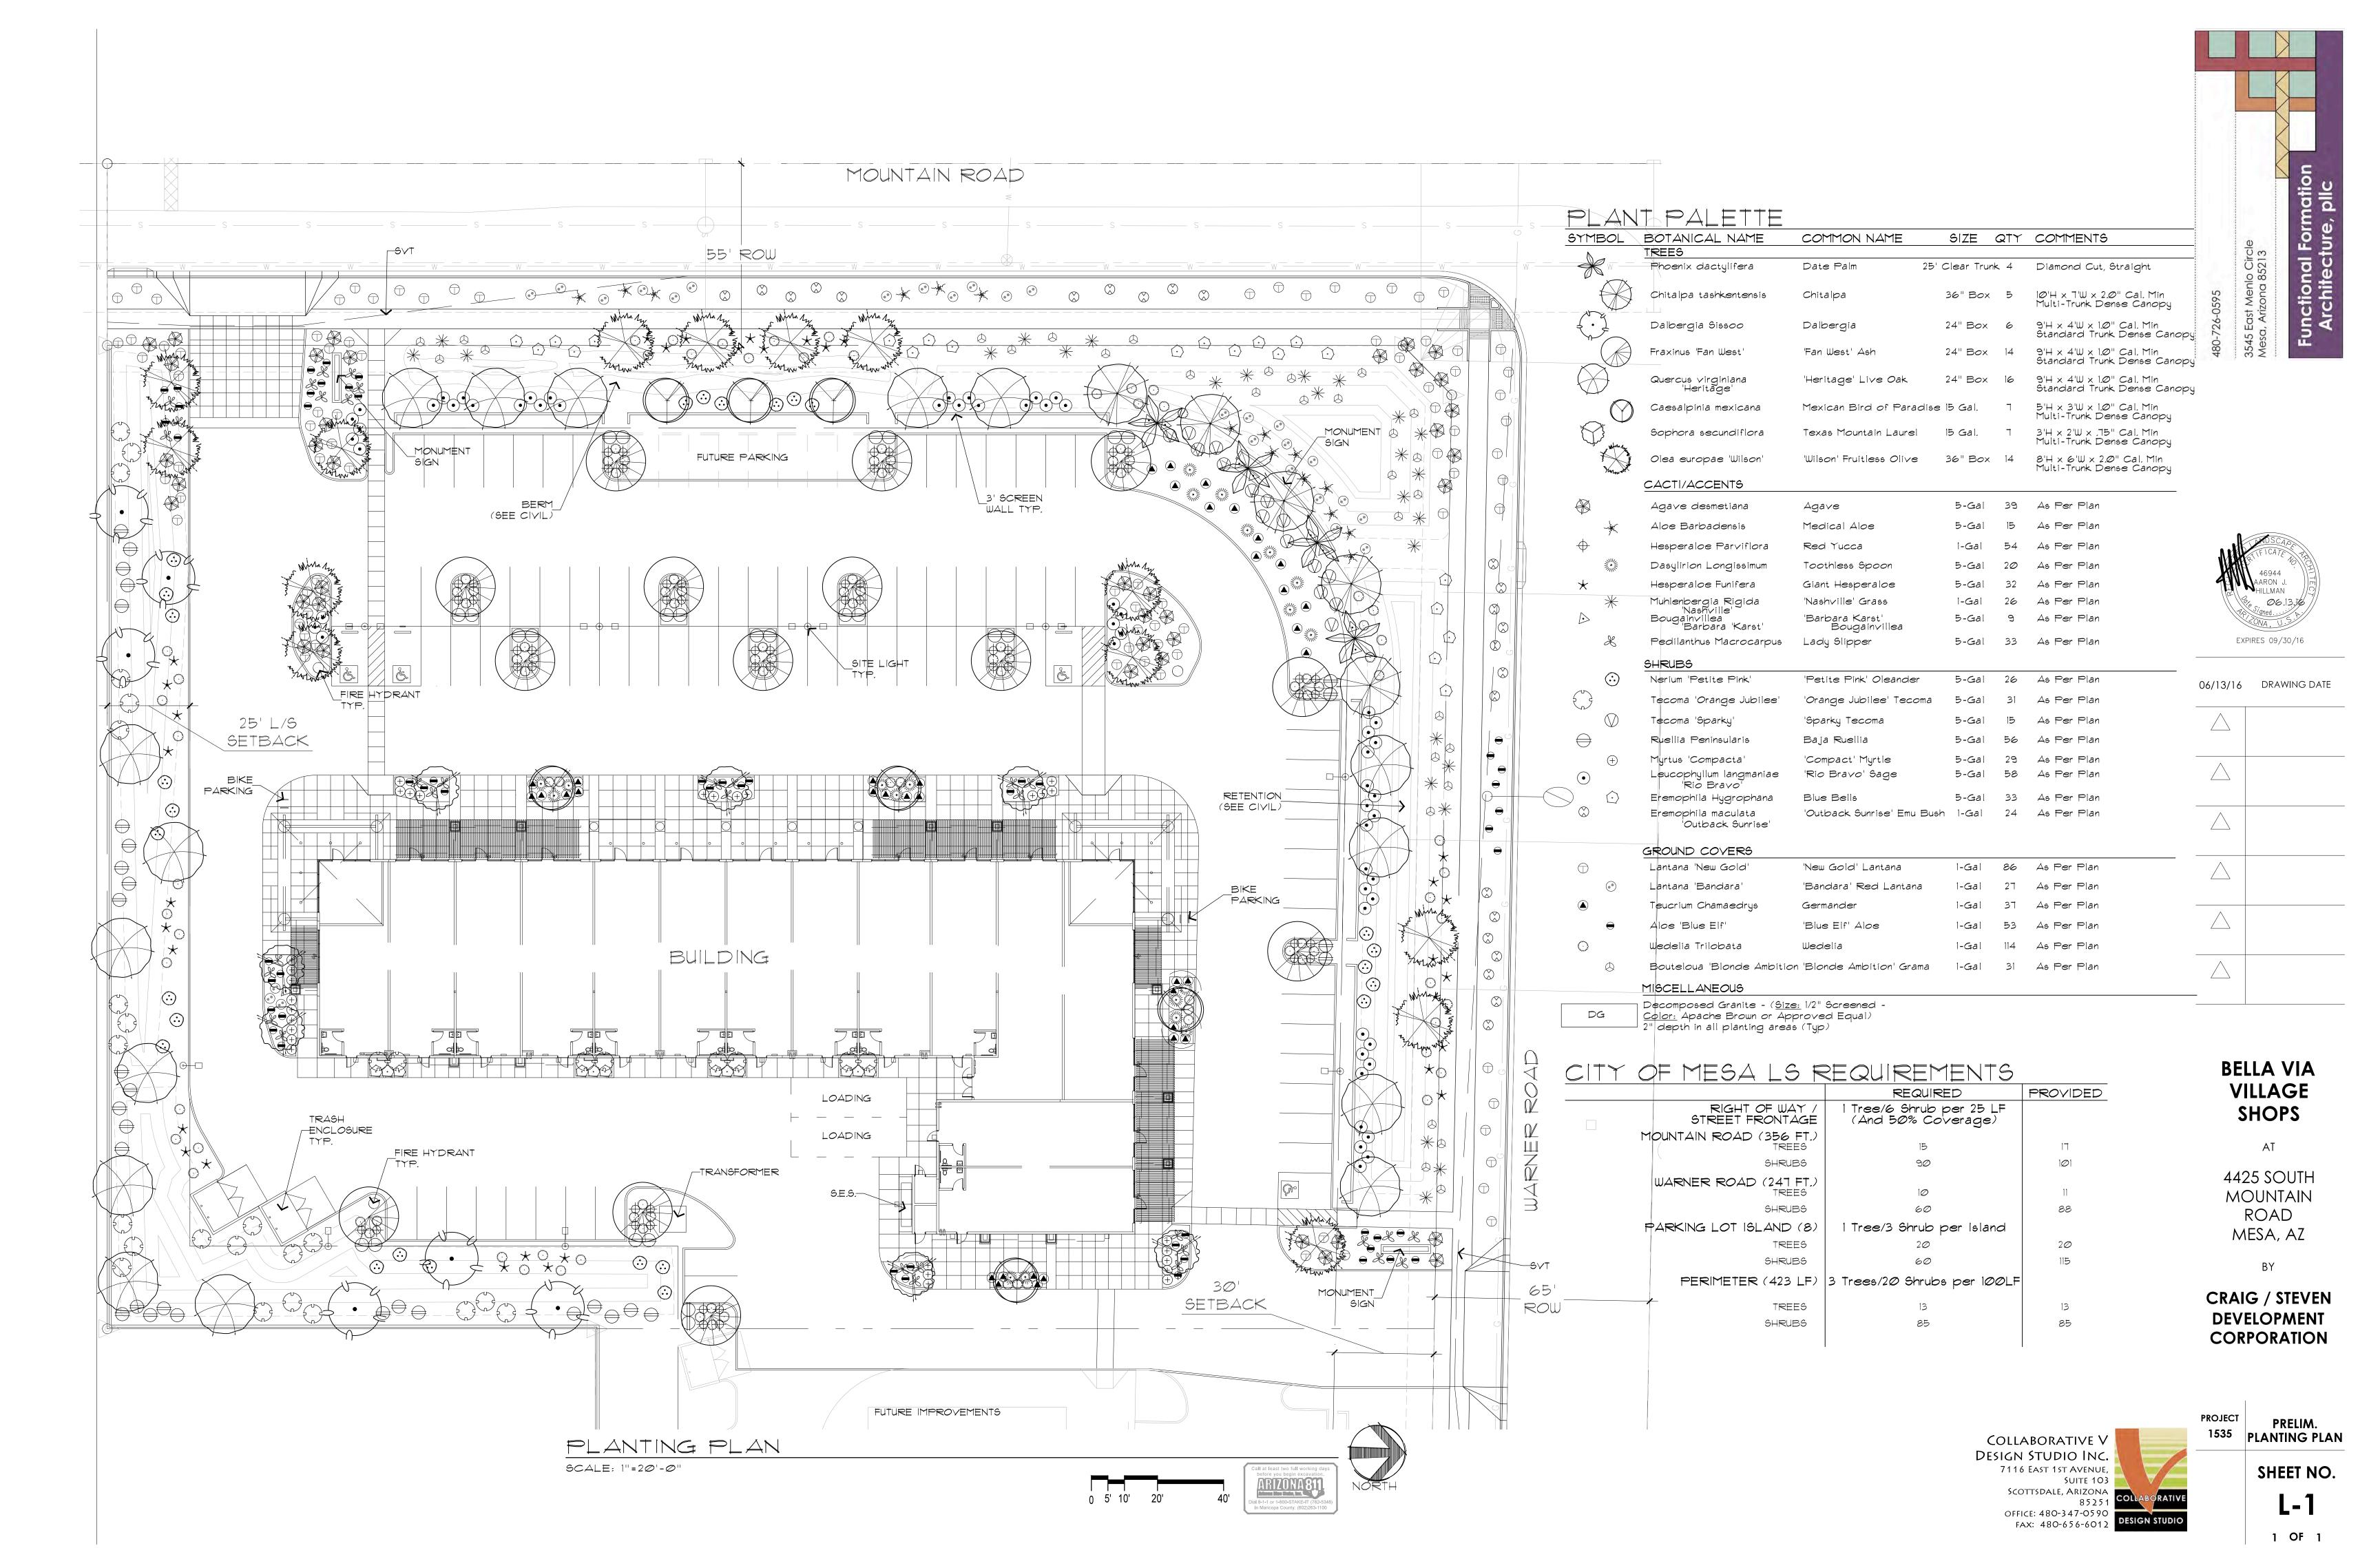

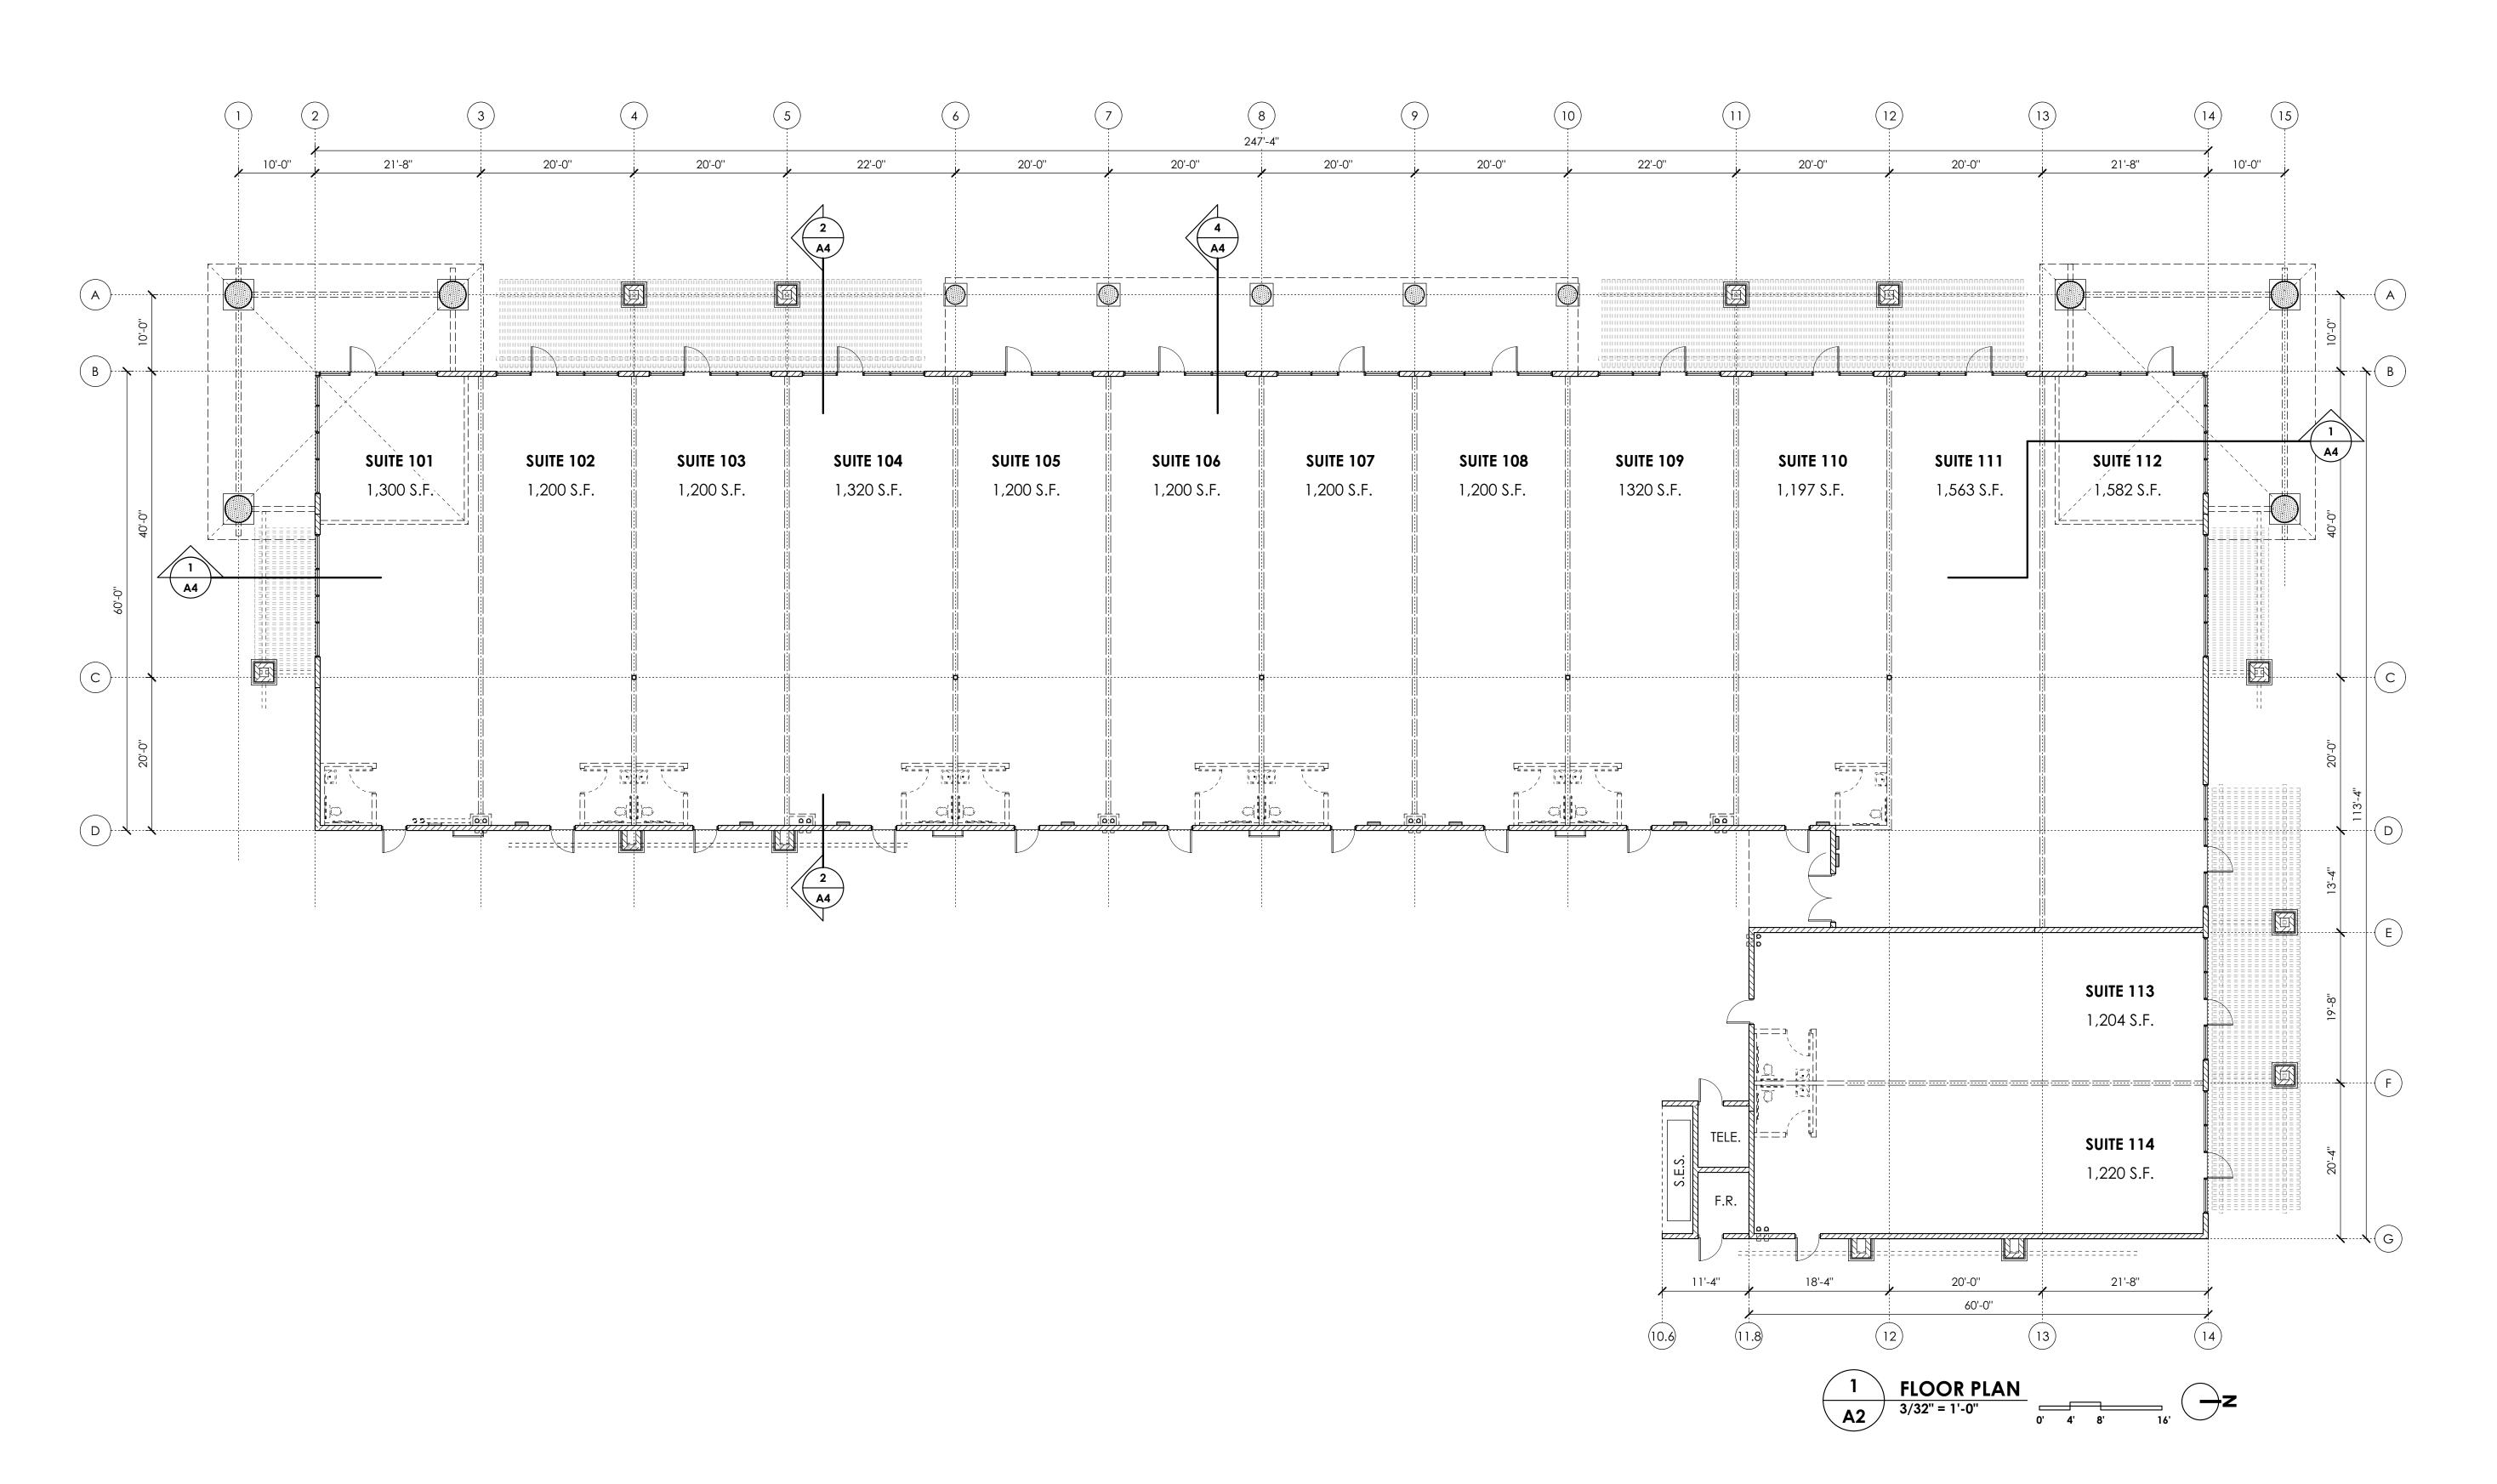

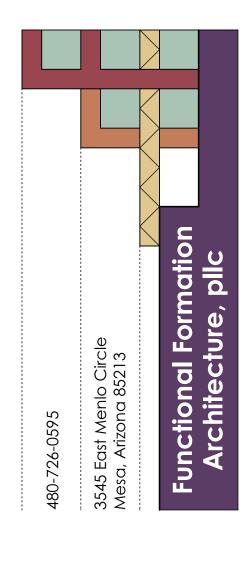



06/17/16	DRAWING DATE
$\triangle$	

# BELLA VIA VILLAGE SHOPS

4425 SOUTH


ΑT


MOUNTAIN ROAD MESA, AZ

CRAIG / STEVEN **DEVELOPMENT** CORPORATION

BY

PROJECT 1535 FLOOR PLAN SHEET NO. **A2** 

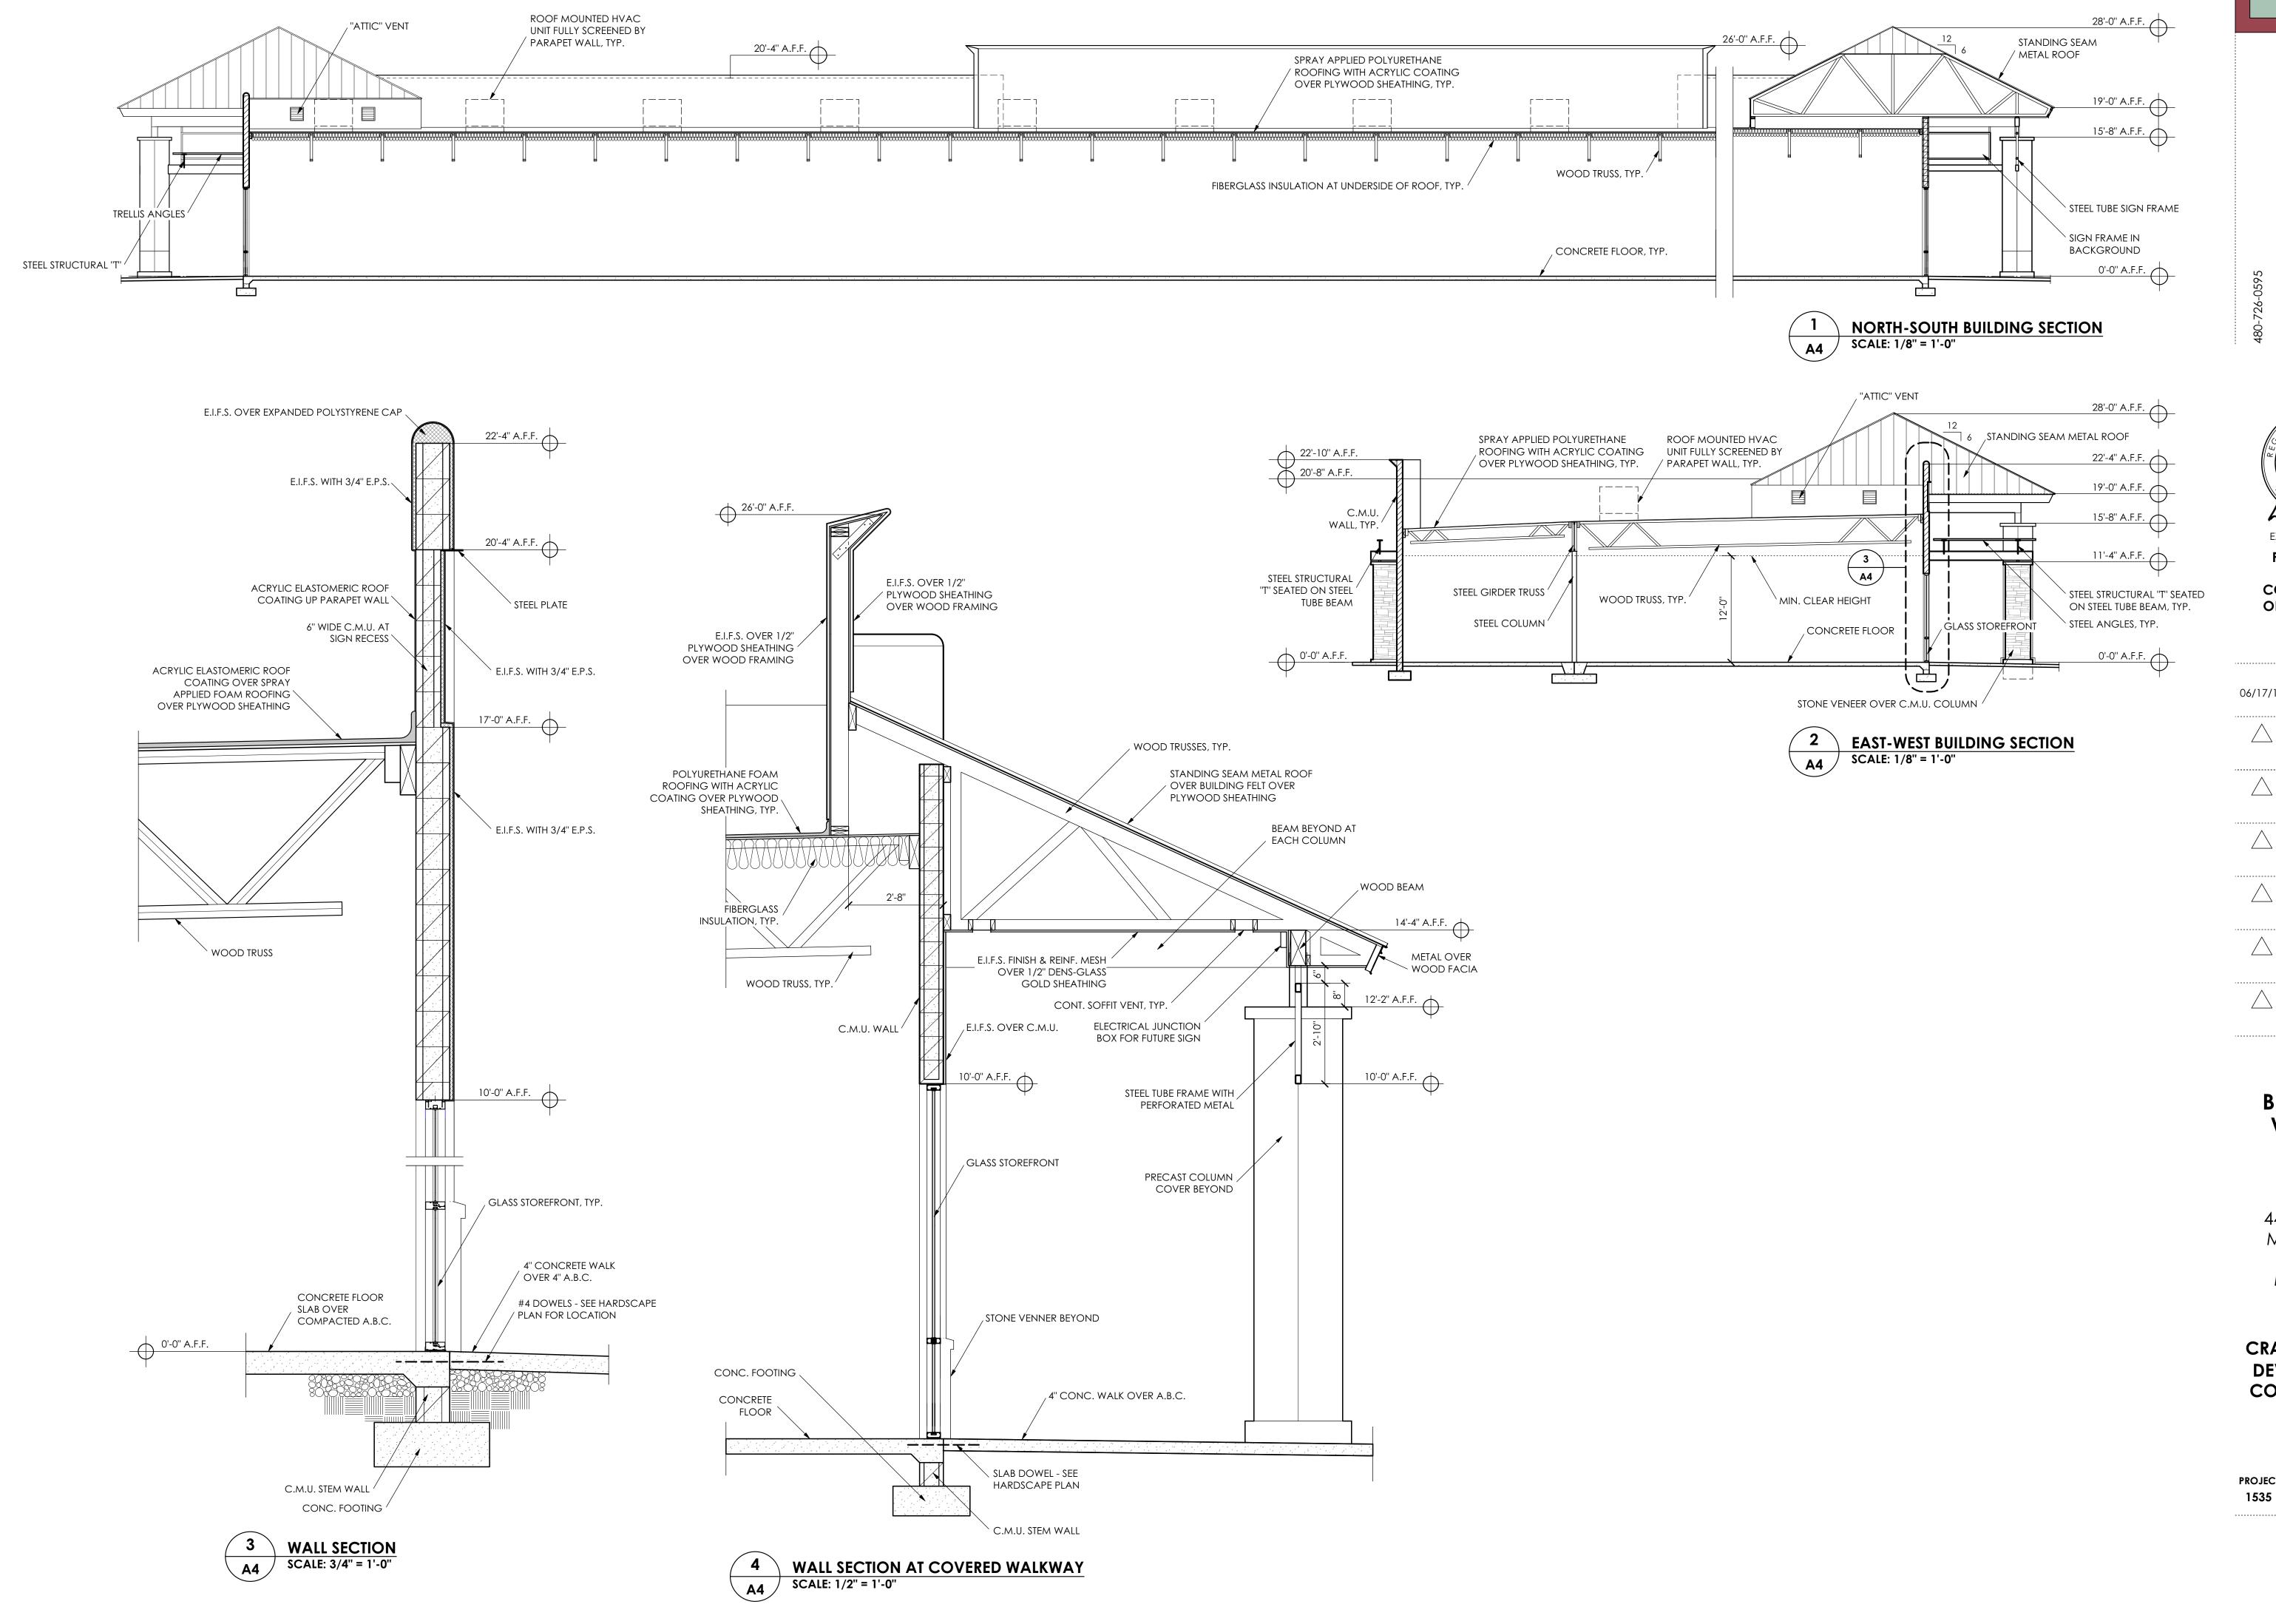

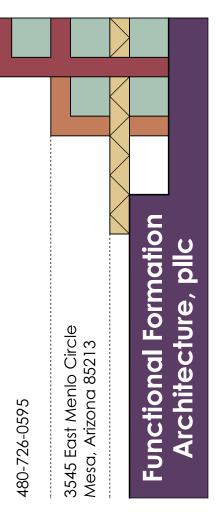



## BELLA VIA VILLAGE SHOPS

ΑT

4425 SOUTH MOUNTAIN ROAD MESA, AZ

BY

## CRAIG / STEVEN DEVELOPMENT CORPORATION

PROJECT	BUILDIN
1535	SECTION

SHEET NO.

A4

## **EXTERIOR MATERIALS**

STANDING SEAM METAL ROOF: SLATE GRAY BY PAC-CLAD, OR APPROVED EQUAL.

E.I.F.S.: INTEGRAL COLOR TO MATCH
DUNN-EDWARDS PIGION GRAY DE6214; AND
INTEGRAL COLOR TO MATCH DUNN-EDWARDS FINE
GRAIN DE6213 (AT WALLS WHERE RAISED PARAPET
OCCURS AT MID SECTION OF WEST ELEVATION AND
AT EAST ELEVATION).

E.I.F.S. OVER P.S. MOLDING: INTEGRAL COLOR TO MATCH DUNN-EDWARDS PIGION GRAY, DE6214.


STONE VENEER: MOUNTAIN LEDGE BUCKSKIN AS MANF. BY ELDORADO STONE.

PRECAST CONCRETE COLUMNS: PEBBLE BY ARISTONE AT COVERED WALK, SAGE BY ARISTONE AT "TOWER" COLUMNS


STEEL TRELLIS & STEEL BEAMS: PAINTED TO MATCH DUNN-EDWARDS LOG CABIN DEA162.

8" x 8" x 16" C.M.U. (RUNNING BOND), TYP.: PAINTED TO MATCH DUNN-EDWARDS TRAIL DUST DE6123.


STOREFRONT WINDOWS: CLEAR GLASS IN DARK ANODIZED BRONZE FINISH.

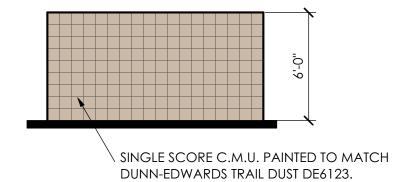





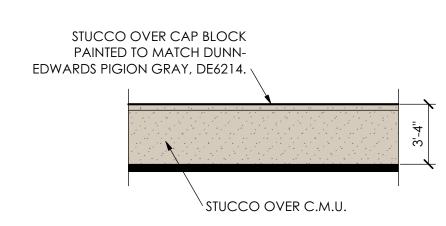





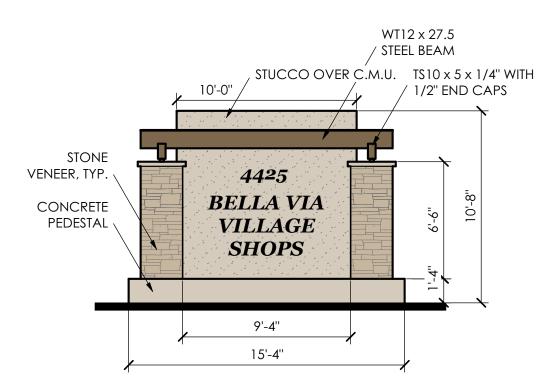

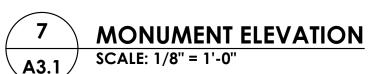


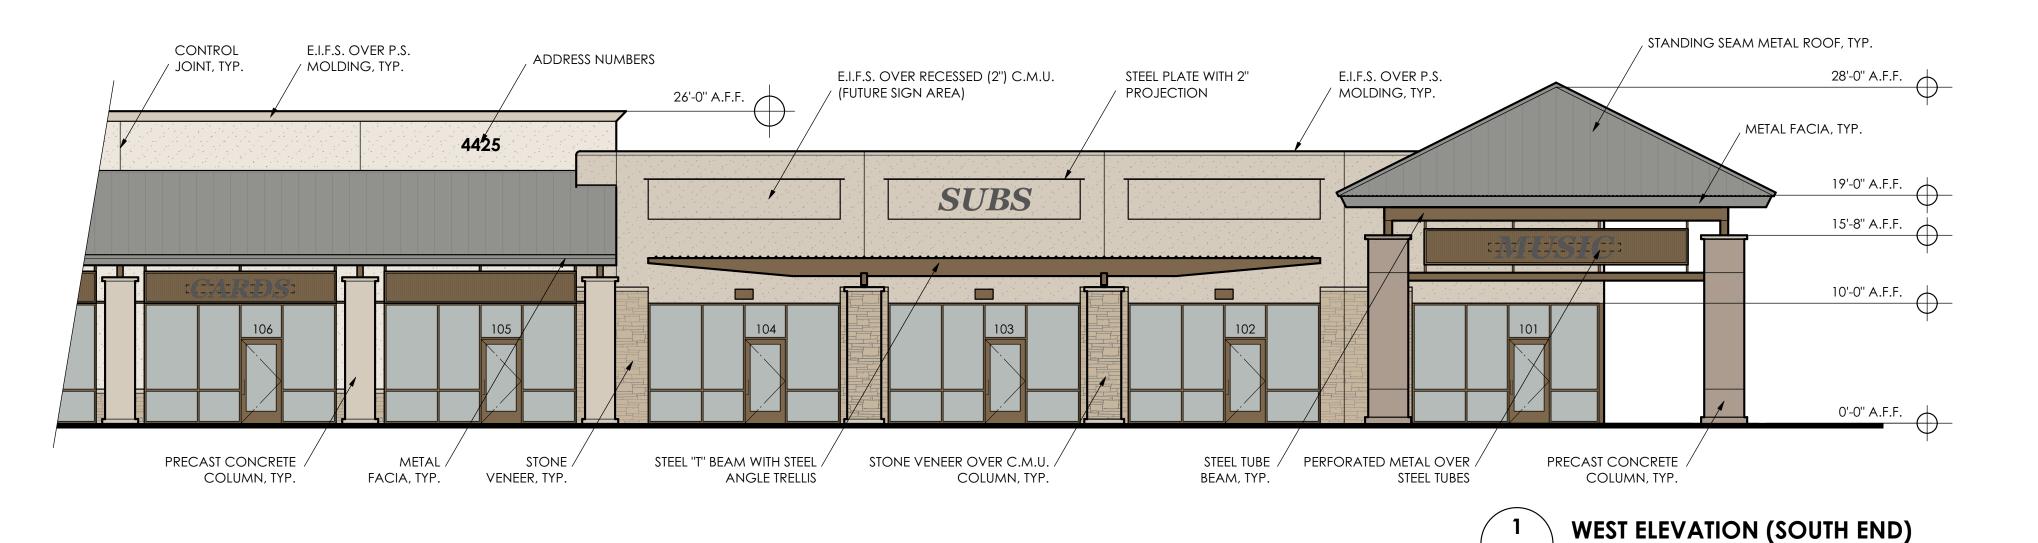


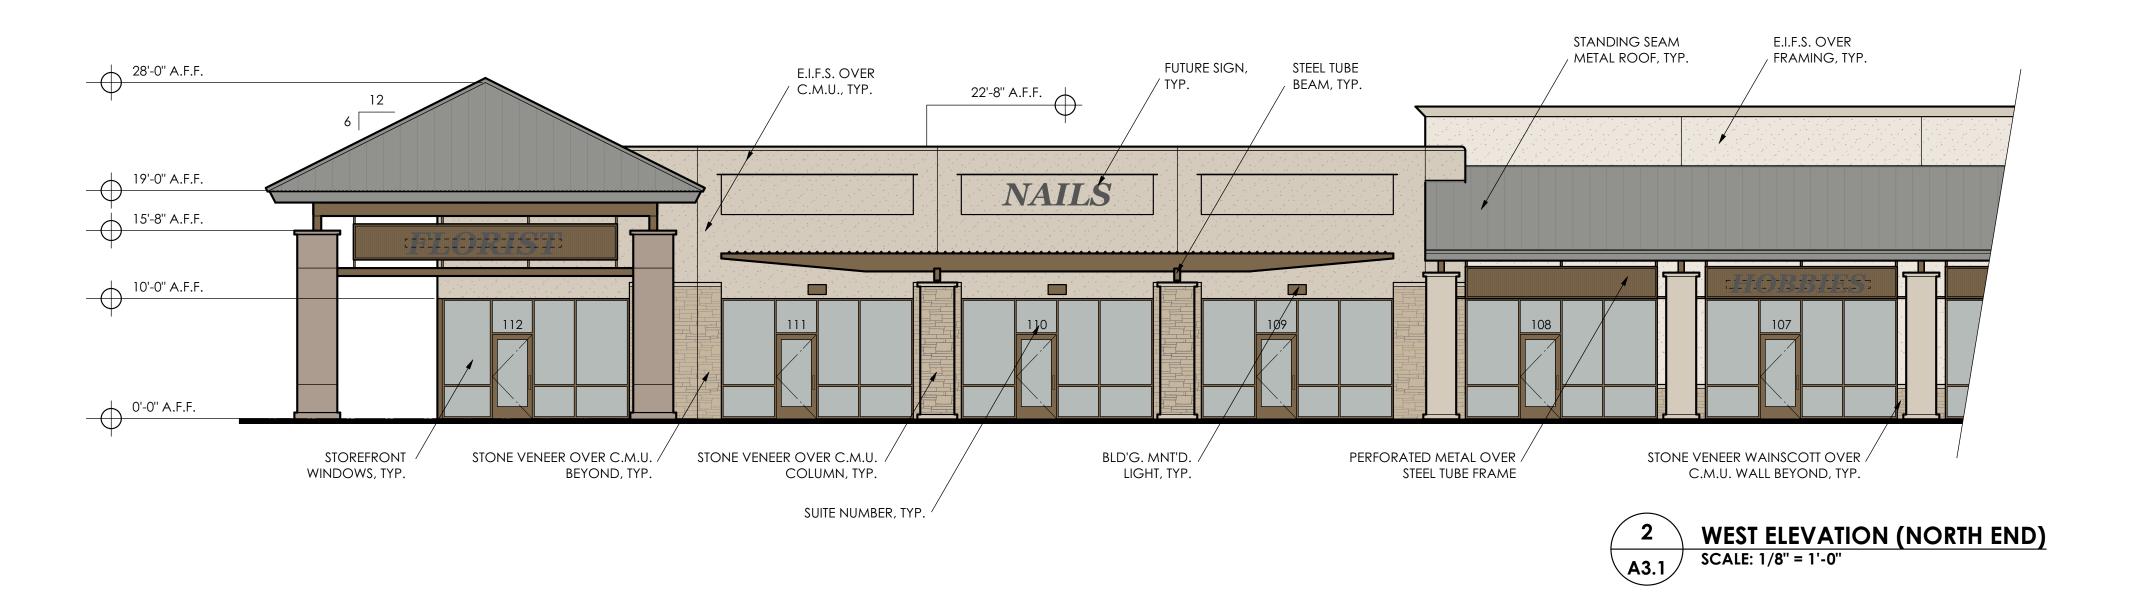

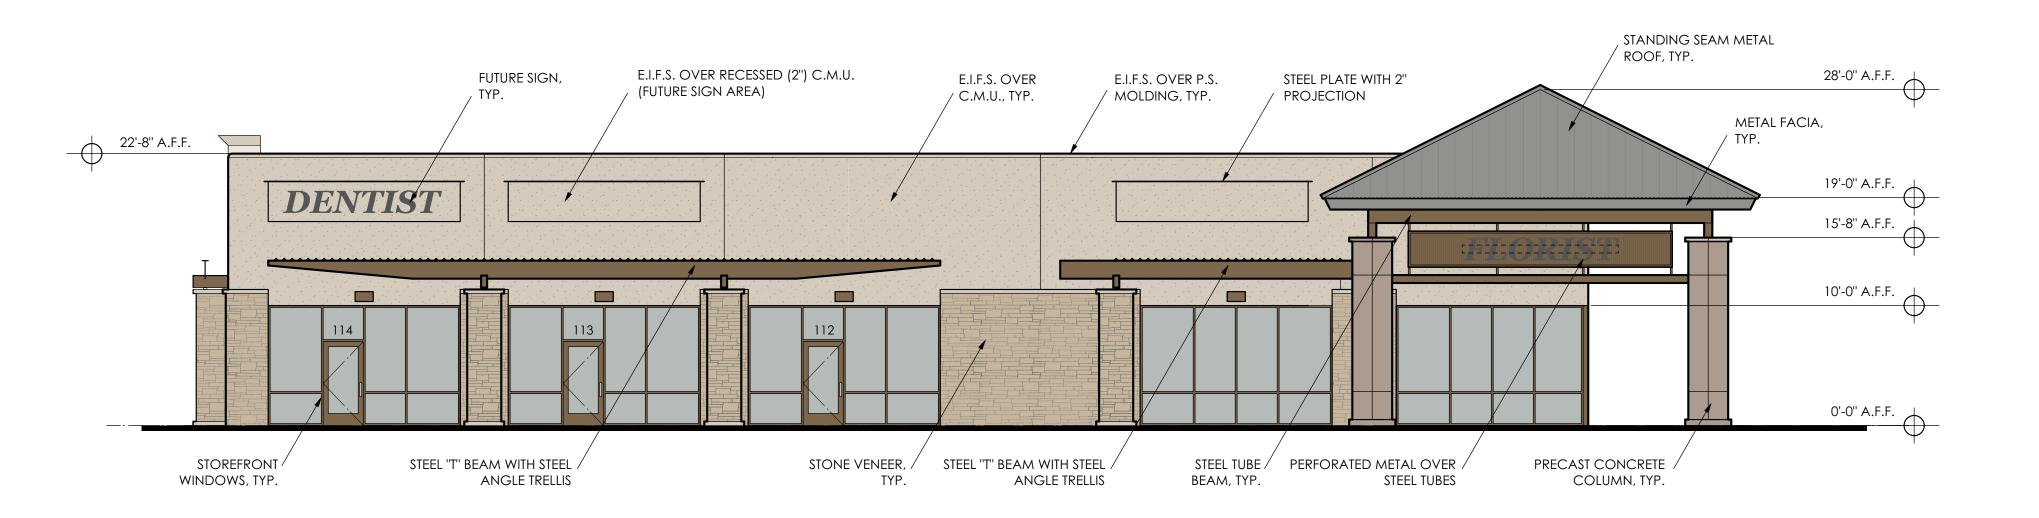



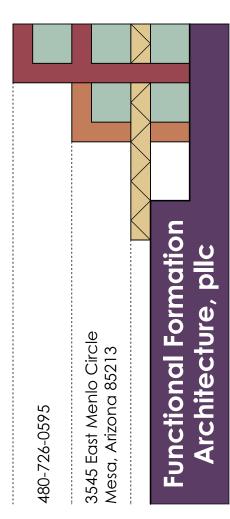

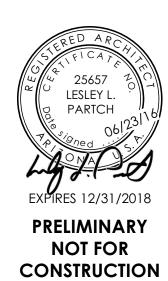

OR RECORDING

SCALE: 1/8" = 1'-0"

**NORTH ELEVATION** 

SCALE: 1/8" = 1'-0"

**\A3.1** 

**\A3.1**/

DRAWING DATE

## BELLA VIA VILLAGE SHOPS

AT

4425 SOUTH MOUNTAIN ROAD MESA, AZ

ВҮ

CRAIG / STEVEN
DEVELOPMENT
CORPORATION

	SHEET NO.				
PROJECT	BUILDING				
1535	ELEVATIONS				

**A3.1** 

## **EXTERIOR MATERIALS**

STANDING SEAM METAL ROOF: SLATE GRAY BY PAC-CLAD, OR APPROVED EQUAL.

E.I.F.S.: INTEGRAL COLOR TO MATCH
DUNN-EDWARDS PIGION GRAY DE6214; AND
INTEGRAL COLOR TO MATCH DUNN-EDWARDS FINE
GRAIN DE6213 (AT WALLS WHERE RAISED PARAPET
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AT EAST ELEVATION).

E.I.F.S. OVER P.S. MOLDING: INTEGRAL COLOR TO MATCH DUNN-EDWARDS PIGION GRAY, DE6214.


STONE VENEER: MOUNTAIN LEDGE BUCKSKIN AS MANF. BY ELDORADO STONE.

PRECAST CONCRETE COLUMNS: PEBBLE BY ARISTONE AT COVERED WALK, SAGE BY ARISTONE AT "TOWER" COLUMNS


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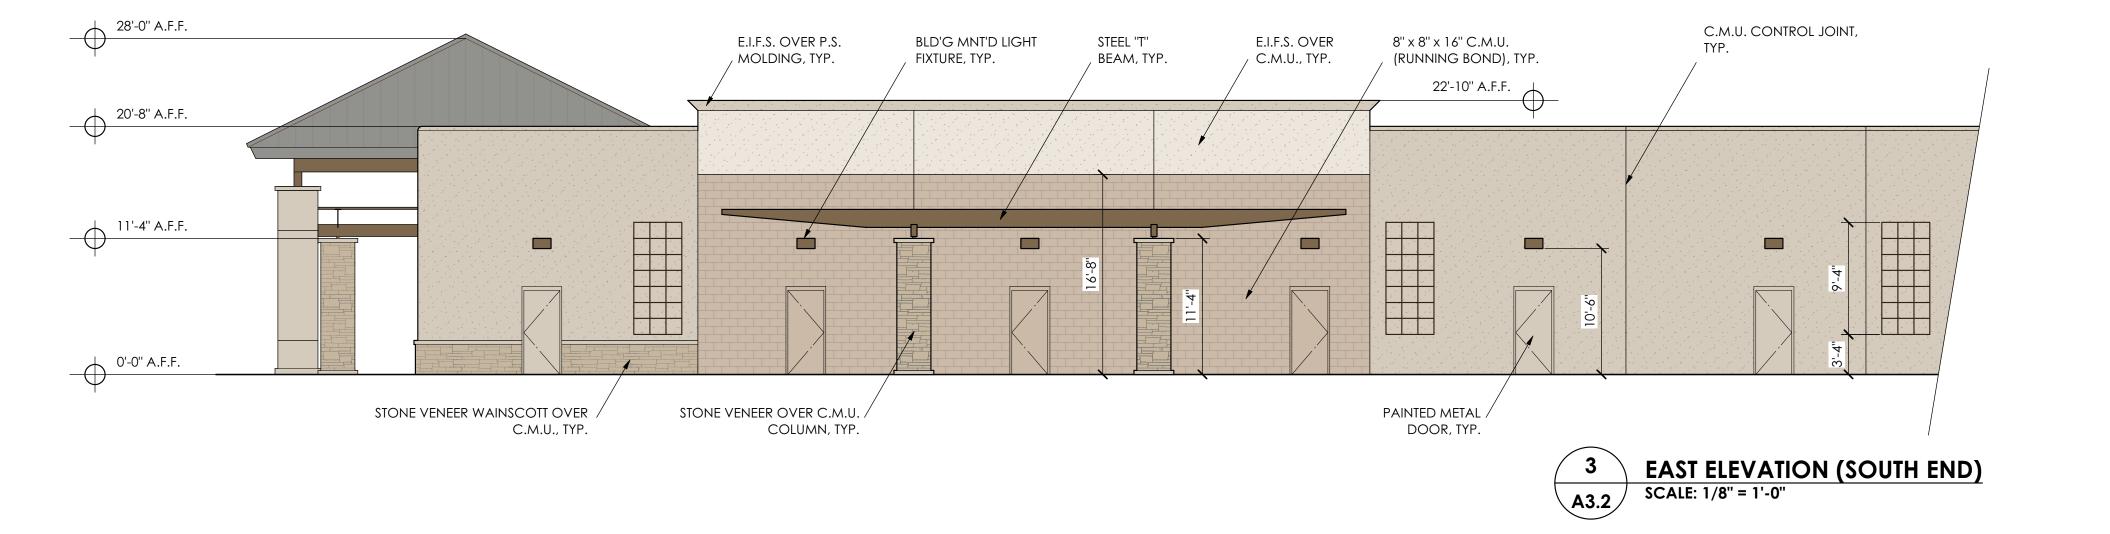
STOREFRONT WINDOWS: CLEAR GLASS IN DARK ANODIZED BRONZE FINISH.






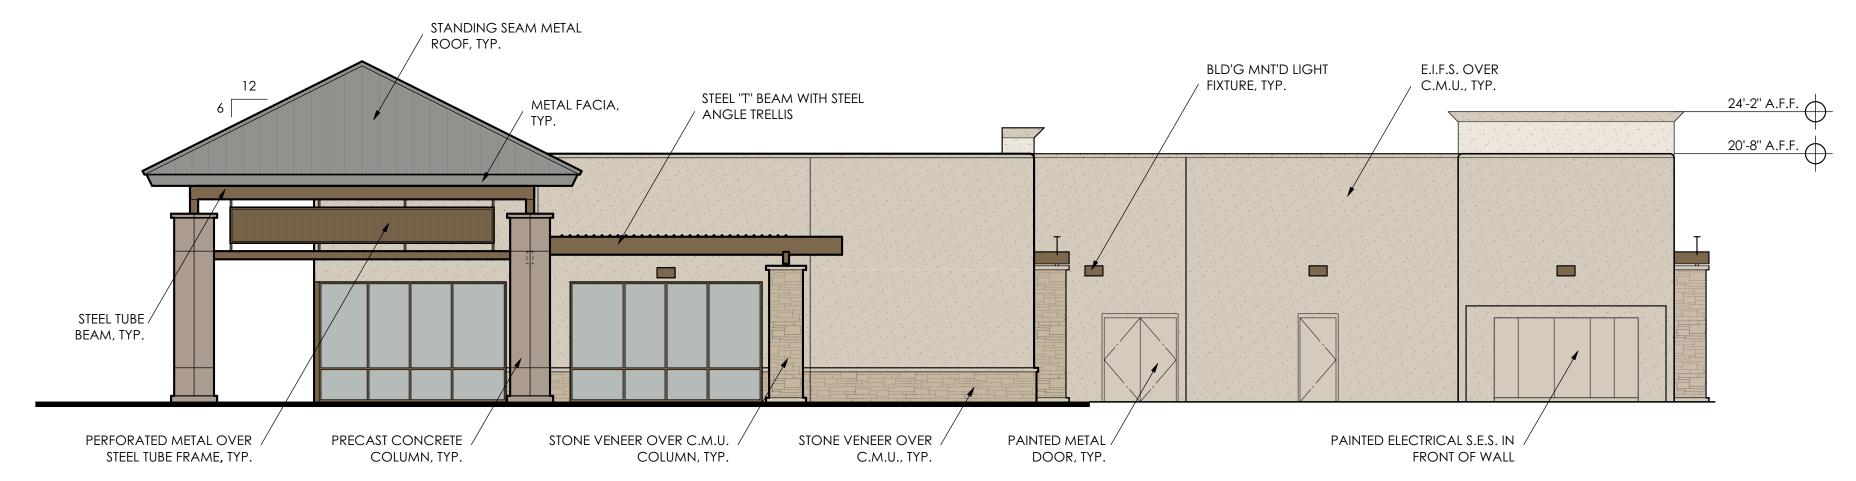

2 EAST ELEVATION (NORTH END)
SCALE: 1/8" = 1'-0"

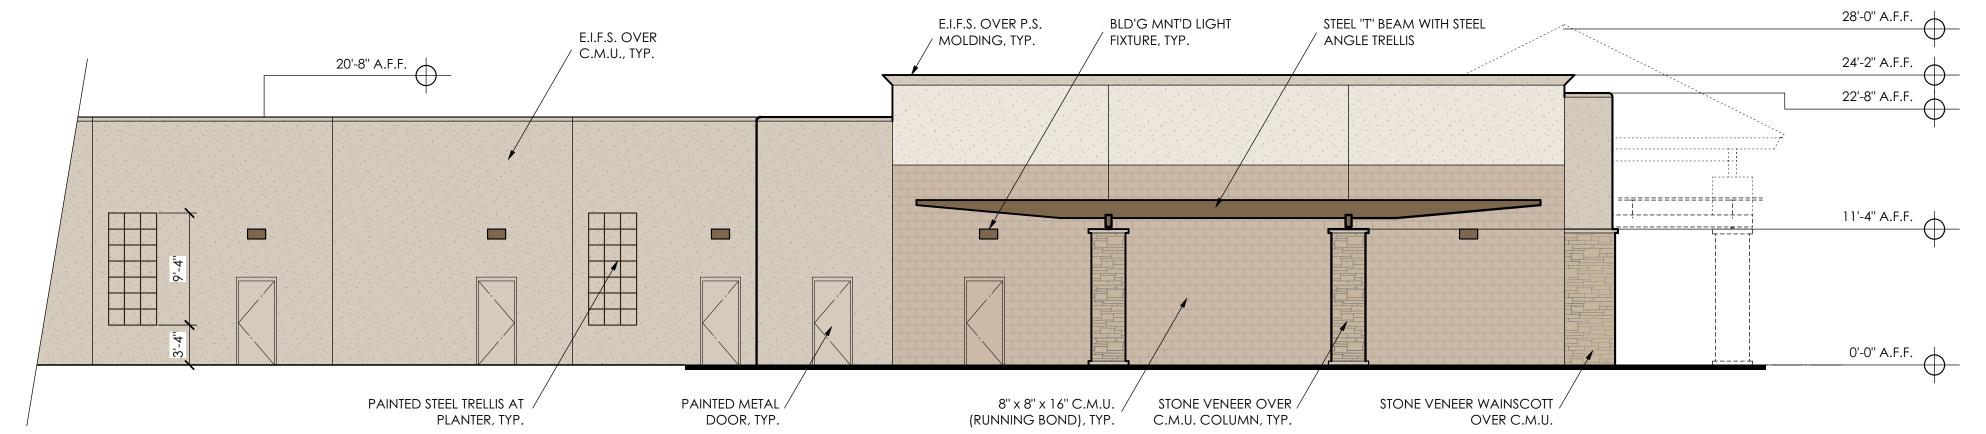

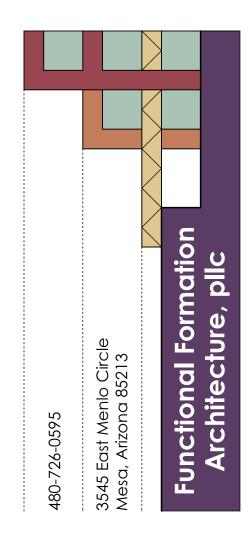



06/17/16	DRAWING DATE
$\triangle$	

## BELLA VIA VILLAGE SHOPS

AT

4425 SOUTH MOUNTAIN ROAD

ВҮ

MESA, AZ

CRAIG / STEVEN
DEVELOPMENT
CORPORATION

BUILDING ELEVATIONS

SHEET NO.

A3.2


OF

#### **BELLA VIA VILLAGE SHOPS**

MATERIAL / COLOR SAMPLES 6/21/16



STEEL TRELLIS &
BEAMS:
DEA162 LOG CABIN

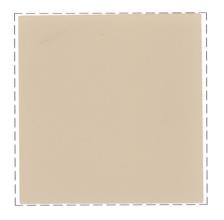


E.I.F.S. & E.I.F.S. OVER
P.S. MOLDING
DE6214 PIGEON GRAY



E.I.F.S. AT RAISED PARAPET WALLS DE6213 FINE GRAIN



STONE VENEER: MOUNTAIN LEDGE BUCKSKIN BY ELDORADO STONE

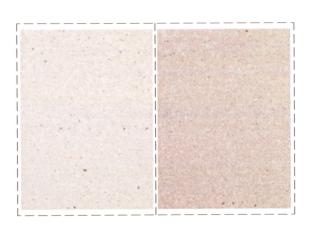

PRECAST CONCRETE
COLUMNS:
PEBBLE / SAGE BY ARISTONE



STANDING SEAM METAL ROOFING: SLATE GRAY BY PAC-CLAD



8" x 8" x 16" C.M.U.: DE6123 TRAILDUST



INTEGRAL COLOR CONCRETE: SIERRA BY DAVIS COLORS



## WSR LED Architectural Wall Sconce











#### **Specifications**

#### Luminaire

Height: (18.4 cm)

18" Width: (45.7 cm)

Depth: (22 8 cm)

17 lbs Weight:




#### **Optional Back Box (BBW)**

Height: (10.2 cm)

5-1/2" Width:

(14.0 cm) 1-1/2" Depth:

(3.8 cm)

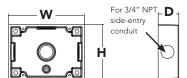

## Catalog Notes Туре

#### Introduction

The classic Architectural Wall Sconce is now available with the latest in LED technology. The result is a long-life, maintenance-free product with typical energy savings of 75% compared to metal halide versions. The integral battery backup option provides emergency egress lighting, without the use of a back-box or remote gear, so installations maintain their aesthetic integrity.

The WSR LED is ideal for replacing existing 50 -175W metal halide wall-mounted products. The expected service life is 20+ years of nighttime use.

#### **Ordering Information**

#### **EXAMPLE:** WSR LED 2 10A700/40K SR3 MVOLT DDBTXD

WSR LED													
Series	Ligh	t Engines	Performance Package		Distrik	oution	Voltage	Mountir	ıg	Options <sup>3</sup>		Finish (requ	ired)
WSR LED	2	One engine (10 LEDs) Two engines (20 LEDs)	700 mA optii 10A700/30K 10A700/40K 10A700/50K	3000K 4000K 5000K	SR2 SR3 SR4	Type II Type IV	MVOLT 1 120 1 208 1 240 1 277 1 347 480	(blank)	d included Surface mount d separately <sup>2</sup> Surface-mounted back box Uptilt 5 degrees	PE SF DF DMG ELCW WLU PIR DS	Photoelectric cell, button type 4.5 Single fuse (120, 277, 347V) 4 Double fuse (208, 240, 480V) 4 0-10V dimming driver (no controls) Emergency battery backup 6 Wet location door for up orientation 7 Motion/ambient light sensor 8 Dual switching 9 Lseparately Vandal guard Wire guard	DDBXD DBLXD DNAXD DWHXD DSSXD DDBTXD DBLBXD DNATXD DWHGXD DWHGXD DSSTXD	Dark bronze Black Natural aluminum White Sandstone Textured dark bronze Textured black Textured natural aluminum Textured white Textured sandstone

#### **Emergency Battery Operation**


The emergency battery backup (ELCW option) is integral to the luminaire - no external housing required! This design provides reliable emergency operation while maintaining the aesthetics of the product.

All ELCW configurations include an independent secondary driver with an integral relay to immediately detect AC power loss. Dual light engines are wired in parallel so both engines operate in emergency mode and provide additional component redundancy. These design features meet various interpretations of NFPA  $70/NEC\ 2008\ -\ 700.16$ 

The emergency battery will power the luminaire for a minimum duration of 90 minutes (maximum duration of three hours) from the time supply power is lost, per International Building Code Section 1006 and NFPA 101 Life Safety Code Section 7.9, provided luminaires are mounted at an appropriate height and illuminate an open space with no major obstructions

The examples below show illuminance of 1 fc average and 0.1 fc minimum of the single-engine Type IV product in

WST LED 1 10A700/40K SR4 MVOLT ELCW 10' x 10' Gridlines 8' and 12' Mounting Height

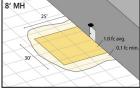



#### NOTES

- MVOLT driver operates on any line voltage from 120-277V (50/60 Hz). Specify 120, 208, 240 or 277 options only when ordering with photocell (PE), fusing (SF, DF), or dual switching (DS).
- May also be ordered separately as an accessory. Ex: WSBBW DDBXD U. Must specify finish.
- Must be ordered with fixture; cannot be field installed.
- Not available with MVOLT option. Button photocell (PE) can be ordered with a dedicated voltage option. Single fuse (SF) requires 120, 277 or 347 voltage option. Double fuse (DF) requires 208, 240 or 480 voltage option.
- Not available with 480V option. Not available with motion/ambient light
- Integral battery pack is rated for -20° to 60°C operating temperature. ELCW warranty is 3-year period. Not available with 347V or 480V. Not available with WLU.
- WLU not available with PIR or ELCW.
- Specifies the SensorSwitch SFOD-7-ODP control (photocell included); see Motion Sensor Guide for details. Includes ambient light sensor. Not available with "PE" option (button type photocell). Dimming driver standard. Not available with WLU, VG or WG.
- Provides 50/50 luminaire operation via two independent drivers and light engines on two separate circuits. Not available with one engine, MVOLT, ELČW, WLU, SF, or DF. Must specify voltage; voltage must be the same for both drivers. When ordered with photocell (PE) or motion sensor (PIR), only the primary power source leads will be controlled.



#### **Performance Data**

#### **Lumen Output**

Lumen values are from photometric tests performed in accordance with IESNA LM-79-08. Data is considered to be representative of the configurations shown, within the tolerances allowed by Lighting Facts.

Light	Drive Current	Performance	System Watts	Dist.		(	40K 4000K, 70 CRI	)	
Engines	(mA)	Package	(MVOLT <sup>1</sup> )	(MVOLT¹) Type	Nominal Lumens	В	U	G	LPW
	1 700 10A700/K		24W	SR2	2,005	1	0	1	84
(10 LED-)		10A700/K		SR3	2,029	1	0	1	84
(10 LEDs)				SR4	1,959	1	0	1	82
2	_	700 10A700/K	47W	SR2	3,944	1	0	1	84
2 (20 LEDs)	700			SR3	4,028	1	0	1	86
(ZU LEDS)				SR4	3,851	1	0	1	82

<sup>1</sup> See electrical load chart for 347/480V system watts.

#### **Lumen Ambient Temperature (LAT) Multipliers**

Use these factors to determine relative lumen output for average ambient temperatures from 0-40  $^{\circ}$ C (32-104  $^{\circ}$ F).

Amb	Ambient				
0°C	32°F	1.10			
10°C	50°F	1.06			
20°C	68°F	1.02			
25°C	77°F	1.00			
30°C	86°F	0.98			
40°C	104°F	0.92			

#### **Projected LED Lumen Maintenance**

Data references the extrapolated performance projections for the **WSR LED 2 10A700** platform in a **25°C ambient**, based on 10,000 hours of LED testing (tested per IESNA LM-80-08 and projected per IESNA TM-21-11).

To calculate LLF, use the lumen maintenance factor that corresponds to the desired number of operating hours below. For other lumen maintenance values, contact factory.

Operating Hours	0	25,000	50,000	100,000
Lumen Maintenance Factor	1.0	0.94	0.88	0.77

#### **Electrical Load**


					Curre	nt (A)		
Light Engines	Drive Current (mA)	System Watts	120	208	240	277	347	480
1	700	24W	0.24	0.14	0.12	0.1	-	-
'	700	29W1	-	-	-	-	0.09	0.07
	700	47W	0.44	0.27	0.23	0.20	-	-
2	700	53W1	-	-	-	-	0.17	0.12


<sup>1</sup> Higher wattage is due to electrical losses from step-down transformer.


#### **Photometric Diagrams**


To see complete photometric reports or download .ies files for this product, visit Lithonia Lighting's WSR LED homepage.


Isofootcandle plots for the WSR LED 2 10A700/40K SR2, SR3, and SR4. Distances are in units of mounting height (12')

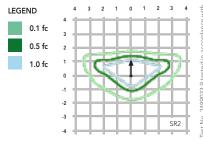

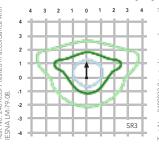

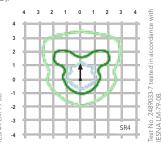

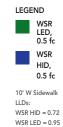

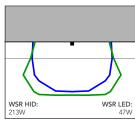

Distribution overlay comparison to 175W metal halide

WSR LED 2 10A700 40K SR4, WSR 175M FT Probe, 12' Mounting Ht

#### **FEATURES & SPECIFICATIONS**

#### INTENDED USE

The classic architectural shape of the WSR LED was designed for applications such as hospitals, schools, malls, restaurants, and commercial buildings. The long life LEDs and driver make this luminaire nearly maintenance-free.

#### CONSTRUCTION

The single-piece die-cast aluminum housing integrates secondary heat sinks to optimize thermal transfer from the internal light engine heat sinks and promote long life. The driver is mounted in direct contact with the casting for a low operating temperature and long life. The die-cast door frame is fully gasketed with a one-piece solid silicone gasket to keep out moisture and dust, providing an IP65 rating for the luminaire.

#### FINISH

Exterior parts are protected by a zinc-infused Super Durable TGIC thermoset powder coat finish that provides superior resistance to corrosion and weathering. A tightly controlled multi-stage process ensures a minimum 3 mils thickness for a finish that can withstand extreme climate changes without cracking or peeling. Standard Super Durable colors include dark bronze, black, natural aluminum, sandstone and white. Available in textured and non-textured finishes.

#### OPTICS

Precision-molded acrylic lenses are engineered for superior distribution, uniformity, and spacing in wall-mount applications. Light engines are 4000K (70 CRI). The WSR LED has zero uplight and qualifies as a Nighttime Friendly™ product, meaning it is consistent with the LEED® and Green Globes™ criteria for eliminating wasteful uplight.

#### ELECTRICAL

Light engine(s) consist of 10 high-efficacy LEDs mounted to a metal core circuit board and integral aluminum heat sinks to maximize heat dissipation and promote long life (100,000 hrs at 25°C, L77). Class 2 electronic driver has a power factor >90%, +1MD <20%. Easily-serviceable surge protection device meets a minimum Category B (per ANSI/IEEE C62.41.2).

#### INSTALLATION

A universal mounting plate with integral mounting support arms allows the fixture to hinge down for easy access while making wiring connections.

#### LISTINGS

CSA certified to U.S. and Canadian standards. Light engines are IP66 rated; luminaire is IP65 rated and suitable for wet locations when mounted with the lenses down. WLU option offers wet location listing in "up" orientation. Rated for -30°C minimum ambient.

DesignLights Consortium® (DLC) qualified product. Not all versions of this product may be DLC qualified. Please check the DLC Qualified Products List at www.designlights.org to confirm which versions are qualified.

#### WARRANTY

Five year limited warranty. Full warranty terms located at www.acuitybrands.com/ CustomerResources/Terms\_and\_conditions.aspx.

**Note:** Actual performance may differ as a result of end-user environment and application. All values are design or typical values, measured under laboratory conditions at 25 °C. Specifications subject to change without notice.





## Refined Styling. Sophisticated Technology.

The modern styling of the D-Series LED Area, Size 1 luminaire is striking yet unobtrusive—making a bold, progressive statement even as it blends seamlessly with its environment. Its outstanding photometric performance results in sites with excellent uniformity, greater pole spacing and lower power density.

#### **Key Features:**

- Energy savings of up to 75% vs. comparable metal halide luminaires; saves
   \$263 per luminaire, per year over 750W metal halide
- 20+ years expected service life (with lumen maintenance up to L99/100,000 hours at 25°C)
- Proprietary precision optics deliver exceptional uniformity and allow for increased spacing, resulting in fewer poles and lower overall cost
- Control options from Acuity Controls include standalone photocell, switched bi-level, part-night scheduled dimming, multi-level motion sensor, and ROAM® wireless monitoring and control

DSX1			
Model	Input Watts	Lumens	Metal Halide Replacement
DSX1 LED 40C 1000 40K T3M	138W	14,888	400W
DSX1 LED 60C 1000 40K T3M	209W	21,910	750W



#### **Quick Facts:**

- Up to 750W MH replacement
- Lumen packages from 6,000 to 23,000 lumens
- Efficacies up to 130 lumens per watt
- 14 factory-rotatable distributions available
- Available in 3000K, 4000K & 5000K CCT and Amber LED
- Weight: 27 lbs; EPA: 1.0 ft <sup>2</sup>

### D-Series LED Area Luminaire, Size 1

#### Ordering Information

#### EXAMPLE: DSX1 LED 60C 1000 40K T3M MVOLT SPA DDBXD

#### **DSX1 LED**

Series	LEDs	Drive Current	Color Temperature	Distribution	Voltage	Mounting
DSX1 LED	Forward optics 30C 30 LEDs (one engine) 40C 40 LEDs (two engines) 60C 60 LEDs (two engines)  Rotated optics 60C 60 LEDs (two engines)	700 700 mA 1000 1000 mA	300 K 40K 4000 K 50K 5000 K AMBPC Amber phosphor converted	T1S Type I Short T5VS Type V Very Short T2S Type II Short T5V Type V Short T2M Type II Medium T5M Type V Medium T3S Type III Short T5W Type V Wide T3M Type III Medium BLC Backlight control T4M Type IV Medium LCCO Left corner cutoff optic TFTM Forward Throw Medium RCCO Right corner cutoff optic	MVOLT 120 208 240 277 347 480	Shipped included SPA Square pole mounting RPA Round pole mounting WBA Wall bracket SPUMBA Square pole universal mounting adaptor RPUMBA Round pole universal mounting adaptor  Shipped separately KMA8 DDBXD U Mast arm mounting bracket adaptor (specify finish)

Control Options (0-10V dimming drivers are standard)				Other Options		Finish (required)	
Shipped installed PER NEMA twist-lock receptacle only (no controls) PER5 Five-wire receptacle only (no controls) PER7 Seven-wire receptacle only (no controls) DS Dual switching BL30 Bi-level switched dimming, 30% Bi-level switched dimming, 50%	PIR PIRH PIR1FC3V PIRH1FC3V PNMTDD3 PNMT5D3 PNMT6D3 PNMT7D3	Motion/ambient sensor, 8-15' mounting height, ambient sensor enabled at 5fc Motion/ambient sensor, 15-30' mounting height, ambient sensor enabled at 5fc Motion/ambient sensor, 8-15' mounting height, ambient sensor enabled at 1fc Motion/ambient sensor, 15-30' mounting height, ambient sensor enabled at 1fc Part night, dim till dawn Part night, dim 5 hrs Part night, dim 6 hrs Part night, dim 7 hrs	Ship HS SF DF L90 R90	House-side shield Single fuse (120, 277, 347V) Double fuse (208, 240, 480V) Left rotated optics Right rotated optics	DDBXD DBLXD DNAXD DWHXD DDBTXD DBLBXD DNATXD DWHGXD	Dark bronze Black Natural aluminum White Textured dark bronze Textured black Textured natural aluminum Textured white	

#### Accessories Ordered and shipped separately.

#### **Controls & Shields**

DLL127F 1.5 JU Photocell - SSL twist-lock (120-277V) DLL347F 1.5 CUL JU Photocell - SSL twist-lock (347V) DLL480F 1.5 CUL JU Photocell – SSL twist-lock (480V) Shorting cap DSHORT SBK U

DSX0HS 20C U House-side shield for 20 LED unit DSX0HS 30C U House-side shield for 30 LED unit DSX0HS 40C U House-side shield for 40 LED unit DSX0DDL U Diffused drop lens (polycarbonate)

PUMBA DDBXD U Square and round pole universal mounting bracket adaptor (specify finish)

KMA8 DDBXD U Mast arm mounting bracket adaptor (specify finish) Please use the spec sheet at www.acuitybrands.com when ordering to ensure component compatibility for your desired configuration.

#### DSX2

400W - 1000W MH Replacement



#### DSX1

250W - 750W MH Replacement





175W - 400W MH Replacement





















